

265 Wadleigh Falls Road Lee, NH 03861 Ph(603)292-5787 WWW.FARWELLENGINEERING.COM

Barrington Planning Board Attn: Ms. Barbara Irvine 333 Calef Highway PO Box 660 Barrington, NH 03825 March 19, 2020

Re:

Wildlife Encounters 270 Beauty Hill Road Tax Map 249 Lot 32 Tax Map 250 Lot 133

FES #1808

Dear Ms. Irvine:

Farwell Engineering Services, LLC (FES) is pleased to submit this letter and revised plans on behalf of Mr. Derek Small of <u>Wildlife Encounters, LLC</u> located at the above noted address. This is in response to plan review letter by DuBois and King dated October 2, 2019.

1. We recommend that the applicant provide a site distance plan and profile in accordance with Site Plan Review Regulations 3.5.9.

Response: We have added a plan and profile of the sight (C-4) distance line of sight in both directions from the proposed end of the driveway. There is over 400 ft of safe all season sight distance.

2. We recommend that the applicant provide the notes on the plan specified in Site Plan Review Regulations 3.2.10.

Response: We have add all notes that are required under site plan review regulations.

We recommend that the applicant revise the plans so that the private driveway maximum grade does not exceed 9%.

Response: The maximum slope of the driveway is proposed to be 9.7% This is less than the 10% required by subdivision regulation 12.3.2 (4). Maximum grade for a driveway is 10%.

4. We recommend that the applicant provide a legend that shows and defines each symbol and linetype used on the plans in accordance with Site Plan Review Regulations 3.2.8.

Response: We have updated the legend to include all linetypes and symbols.



Wildlife Encounters Barrington, NH Page 2

5. Sheet C-2. We recommend that the applicant revise the proposed drainage pipe to meet the requirements of Site Plan Review Regulations 4.7.7(1), which requires a minimum pipe diameter of 15".

Response: The drainage pipe leaving the detention basin is used to control the flow leaving the detention basin and should be a 12" diameter pipe. We request a waiver if required.

6. Sheet C-2. We recommend that the applicant revise the plan to show all proposed temporary erosion protection measures during construction (silt fence, hay bales, etc.) on the plan and their associated details,0 in accordance with Site Plan Review Regulations 3.5.3.

Response: The review engineer did not have the complete plan set as this was intended to review the drainage only. The silt fence and silt sock detail is on details sheet D-1, and shown on the site plan.

7. Sheet C-2, Drainage Post- Development Drawing DR-2. The proposed grading and stormwater flow appears to flow directly through a line that is assumed to denote an existing rock retaining wall. It is unclear if stormwater will flow through the wall or if the wall will act as a barrier. We recommend that the applicant clarify the drainage flow pattern in this area and consider adding a defined flow path without a rock wall obstruction.

Response: The stonewall is not a barrier. The grades send the stormwater in this direction and water flows through the stone wall.

8. Sheet C-2. We recommend that the applicant perform test pits to confirm that the proposed stormwater system retention is above the estimated seasonal high water table (ESHWT) elevations.

Response: We have performed a test pit in the area of the detention basin. ESHWT was at 24". The pond bottom is above the ESHWT.

 Sheet D-2. Details. We recommend that the applicant provide a detail of the stormwater retention pond that depicts the embankment section, embankment material compaction and gradation requirements, limits of riprap slope stabilization, and inverts of the emergency overflow spillway.

Response: We have provided grading information as well as compaction information for the detention pond. This is found on the detail sheet D-3 and the site plan C-2.

10. Sheet D-2. Details. We recommend that the applicant provide a pipe trench detail that depicts the compaction and material requirements for the stormwater drainage.

Response: We have added a trench detail on sheet D-2.

11. Sheet D-2. Details. Outlet Control Structure No. 1 Detail. We recommend that the applicant provide stone bedding wrapped in geotextile for the base of the outlet control structure.

Response: We have added a bedding detail note for the outlet control structure on Sheet D-3.

12. Sheet D-2. Details. We recommend that the applicant provide a typical section for the driveway.

Response: There is a typical section shown the profile sheet.





Wildlife Encounters Barrington, NH Page 3

13. Drainage Analysis. Riprap Outlet Protection. We recommend that the applicant provide riprap apron and stone sizing calculations in the drainage analysis in accordance with Site Plan Review Regulations 4.7.2(11), and that the required dimensions and stone size are clearly defined on the drawings.

Response: We have provided rip rap sizing calcuations to the drainage analysis. The rip rap information is added to the plans on sheet D-3.

14. Drainage Analysis. The outlet control structure (Pond 2P) culvert length and outlet invert elevation does not match Sheet C-2. We recommend that the applicant revise the submitted materials to match.

Response: We have updated the drainage analysis to match the plans.

15. Drainage Analysis. The Table of Contents indicate that AOT worksheets are included in the analysis. No worksheets were provided. We recommend that the applicant revise the drainage analysis to provide stormwater treatment and pre-treatment calculations that meet the requirements of the NH Stormwater Design Manual in accordance with Site Plan Review Regulations 4.7.2(10). We anticipate that the applicant can utilize the grass lined swale as a vegetated treatment swale.

Response: We have provided the pre-treatment analysis for the grass lined swale. The worksheet is included in the drainage analysis.

16. Drainage Analysis. Watershed Plans DR-1 and DR-2. We recommend that the applicant revise the pre- and post-development watershed delineations to both have at least 2 points of analysis into the receiving watershed downstream. For example, the runoff associated with "2S" in the post-development model should be a separate point of analysis so that the effects of the disturbed areas associated with the proposed gravel parking lot can be compared more accurately.

Response: We have revised the drainage analysis to include two study points. We have also elongated the swale to capture additional runoff from the newly proposed 50' x 80' Building window and gravel drive.




Wildlife Encounters Barrington, NH Page 4

Thank you for your time and consideration in this matter. Please contact me is you have additional comments.

Sincerely,

FARWELL ENGINEERING SERVICES, LLC

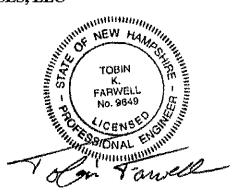

Tobin Farwell, P.E. Principal

ABUTTERS LIST

MAP/LOT name and mailing address 239/61 LITCHFIELD, CT 06759 249/27

MORRISON PAUL 249/28 DIANOS & NHOL SONALD

GRIFFIN JAY DONN-GRIFFIN DEBRA 272 BEAUTY HILL RD

250/34

TICE DYLAN M & AIMEE J KLOPMAN ANDREA A & ARTHUR W 5226 STATE RT 145 COBBLESKILL, NY 12043 250/34-1

STOLZENBURG PAUL & CAROLYN

TIJERINA ANTHONY 4/5 INT SANDERS 250/36 TAI BOT BICHARD & HEATHER

250/119 PUBLIC SERVICE CO NH PO BOX 270 HARTFORD, CT 06141

250/121

250/133

CAMPBELL RICHARD & SARAH PO BOX 500 BARRINGTON, NH 03825

SURVEYOR:



Licensed in New Hampshire & Maine PO Box 458, Barrington, NH 03825

WETLAND SCIENTIST:

NOTES- CONTINUED:


- 11. WATER IS PROVIDED BY ONSITE WELL. SEWER IS SERVICED BY ON SITE LEACHFIELD.
- 12. FEMA INFORMATION PROVIDED ON EXISTING CONDITIONS PLAN
- 13. THIS PROJECT REQUIRES A SEPTIC PERMIT # THIS PROJECT REQUIRES A WETLANDS PERMIT #
- 14. IF, DURING CONSTRUCTION, IT BECOMES APPARENT THAT DEFICIENCIES EXIST IN THE APPROVED DESIGN DRAWINGS, THE CONTRACTOR SHALL BE REQUIRED TO CORRECT THE DEFICIENCIES TO MEET THE REQUIREMENTS OF THE REGULATIONS AT NO
- 16. IF, DURING CONSTRUCTION, IT BECOMES APPARENT THAT ADDITIONAL EROSION CONTROL MEASURES ARE REQUIRED TO STOP ANY EROSION ON THE CONSTRUCTION SITE DUE TO ACTUAL SITE CONDITIONS, THE OWNER SHALL BE REQUIRED TO INSTALL THE NECESSARY EROSION PROTECTION AT NO EXPENSE TO THE TOWN.
- 17. ALL MATERIALS AND METHODS OF CONSTRUCTION SHALL CONFORM TO THE TOWN OF BARRINGTON SITE REVIEW REGULATIONS AND THE LATEST EDITION OF THE NEW HAMPSHIRE DEPARTMENT OF TRANSPORTATIONS STANDARD SPECIFICATIONS FOR ROAD AND BRIDGE CONSTRUCTION.

Site Plan FOR WILDLIFE ENCOUNTERS ECOLOGY CENTER **AND FARM SCHOOL**

Property located at: 270 Beauty Hill Road TAX MAP 249, LOT 32

TAX MAP 250, LOT 133 Barrington, New Hampshire

POORLY DRAINED SOILS

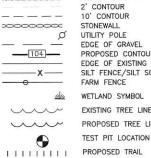

LEGEND


CONSTRUCTIN TIME TABLE:

5. PARKING- GRAVEL PARKING AREA = 20 SPACES. PARKING ADJACENT TO ROAD = 12 SPACES.

EMPLOYEE PARKING — 3 EMPLOYEES

AND HANDICAP PARKING IS AT RESIDENCE. PROPOSED WOODS TRAIL

- 1. BARN UNDER CONSTRUCTION TO BE COMPLETED BY SUMMER OF 2020. 2. THE WOODS TRAIL SPINC OF 2020. 3. DRIVEWAY PARKING AND DETENTION POND UNDER
- CONSTRUCTION SUMMER OF 2020.
 4. CONSTRUCTION TIME TABLE IS SUBJECT TO FUNDING

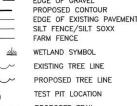

6. THERE IS ANTICIPATED TO BE 18-20 EVENTS PER WEEK MAXIMUM. THE BUSIEST SEASON IS ANTICIPATED TO BE SUMM

LOCATION PLAN

2. OWNER OF RECORD: DWSX2 HOLDINGS LLC c/o DEREK SMALL S.C.R.D. BOOK 4728 PAGE 370

DATED JANUARY 22, 2020

FRONT BUILDING SETBACK:

SIDE AND REAR SETBACK:

MAXIMUM COVERAGE:

LOT IS ZONED NEIGHBORHOOD RESIDENTIAL MINIMUM FRONTAGE: 200 FT

1 TAX MAP 249/250 LOT 32/133 75+/- ACRES

4. THE INTENT OF THIS PLAN IS TO CONSTRUCT A DRIVEWAY AND PARKING AREA AND OTHER IMPROVEMENTS INCLUDE DETENTION POND AND SWALE.

7. HOURS OF OPERATION ARE BY APPOINTMENT

8. MANURE FOR LIVESTOCK WILL BE COMPOSTED ON THE EAST PORTION OF THE PROPERTY. 9. THE SITE IS CURRENTLY RESIDENTIAL. PROPOSED USE

10. LOT COVERAGE 2500 SF/75 ACRES = 0.08%

WAIVER REQUESTS:

TOWN OF BARRINGTON SITE PLAN REVIEW REGULATIONS: ARTICLE 4.9.8 PARKING LOT LIGHTING REQUIREMENTS. WE ARE PROPOSING NO LIGHTING FOR THE PARKING AREA.







ISSUED FOR:

SITE PLAN REVIEW

JUNE 26, 2019

FILE NAME:

1808-DS

(3)

DWSX2 HOLDINGS LLC

C/O DEREK SMALL


1" = 40'

WILDLIFE ENCOUNTERS ECOLOGY CENTER 270 BEAUTY HILL RD BARRINGTON, NH 03825

TAX MAP/LOT 250/133 & 249/32 270 BEAUTY HILL BARRINGTON, NH

COVER SHEET

SHEET NUMBER:

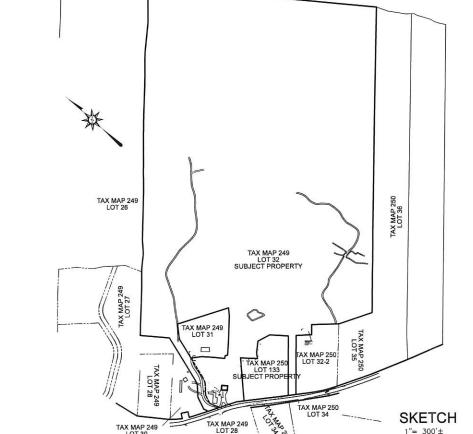

TAX MAP 239 LOT 61

SHEET INDEX:

EXISTING CONDITIONS BOUNDARY COMPILATION AND TOPOGRAPHY PLAN

C-2

C-3 C-4

C-5

PLANNING BOARD APPROVAL BLOCK


COVER SHEET BY STONEWALL SURVEYING BY STONEWALL SURVEYING SITE PLAN **PROFILE**

SIGHT DISTANCE


PATH PROFILE


D-1 SEPTIC PLAN


DETAILS DETAILS **DETAILS** BY SCOTT BAILEY

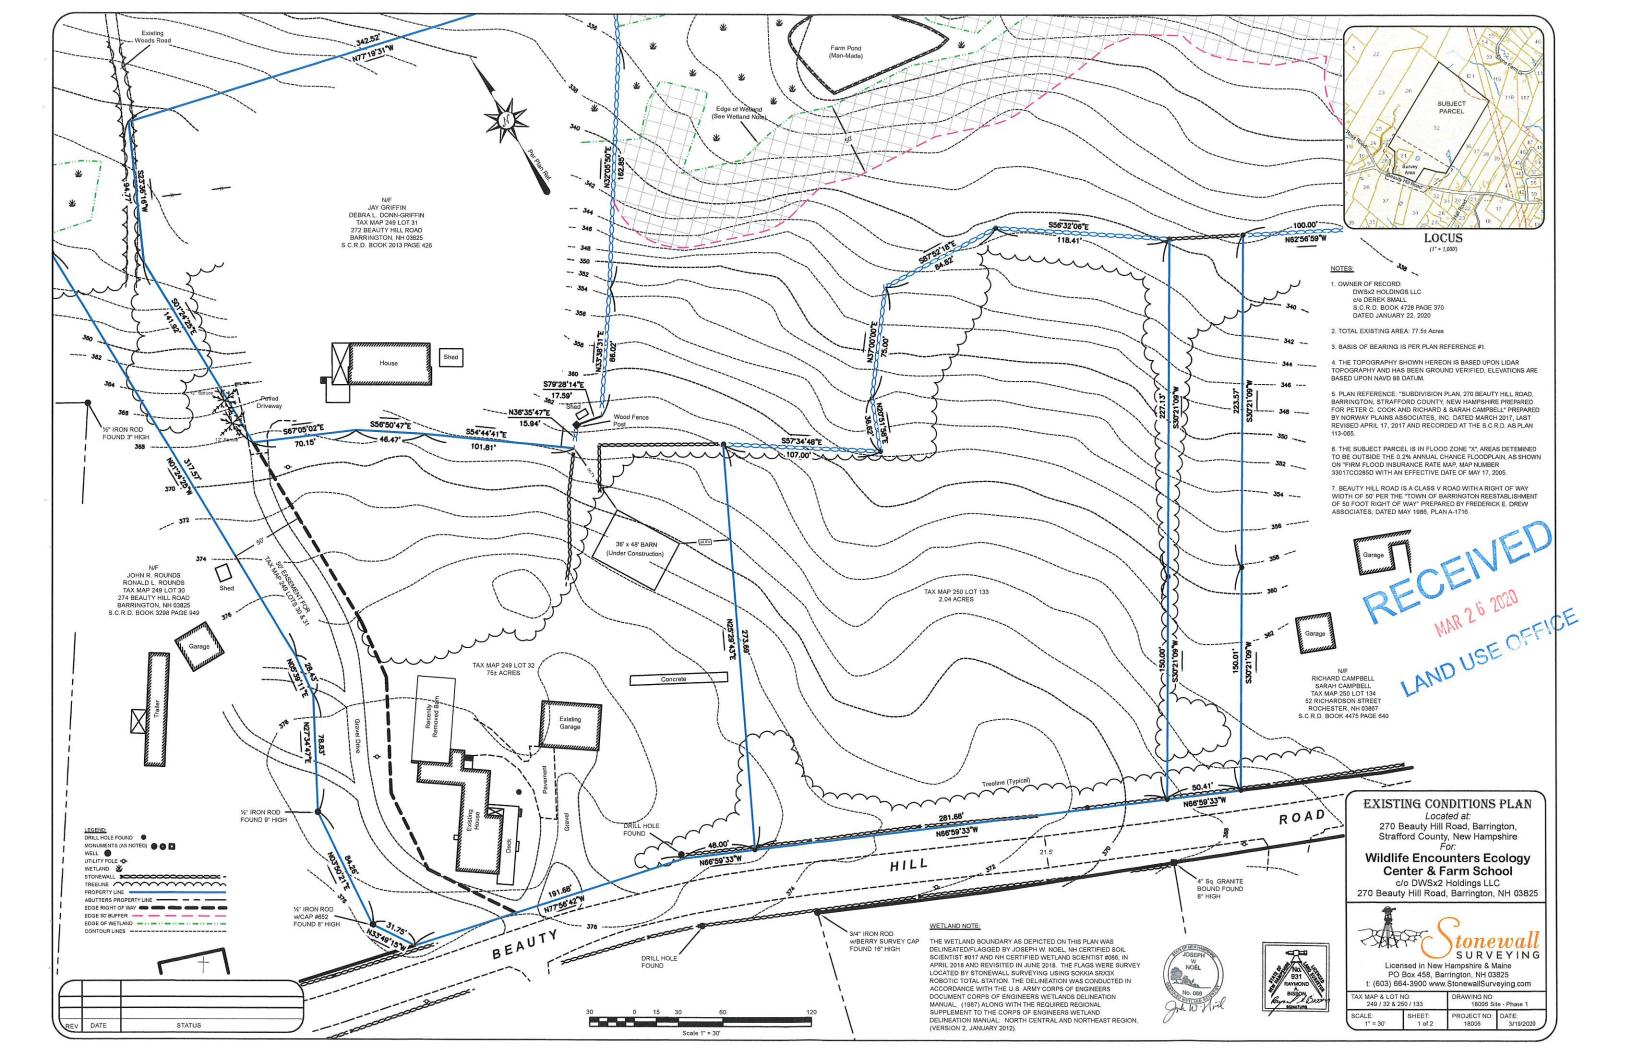




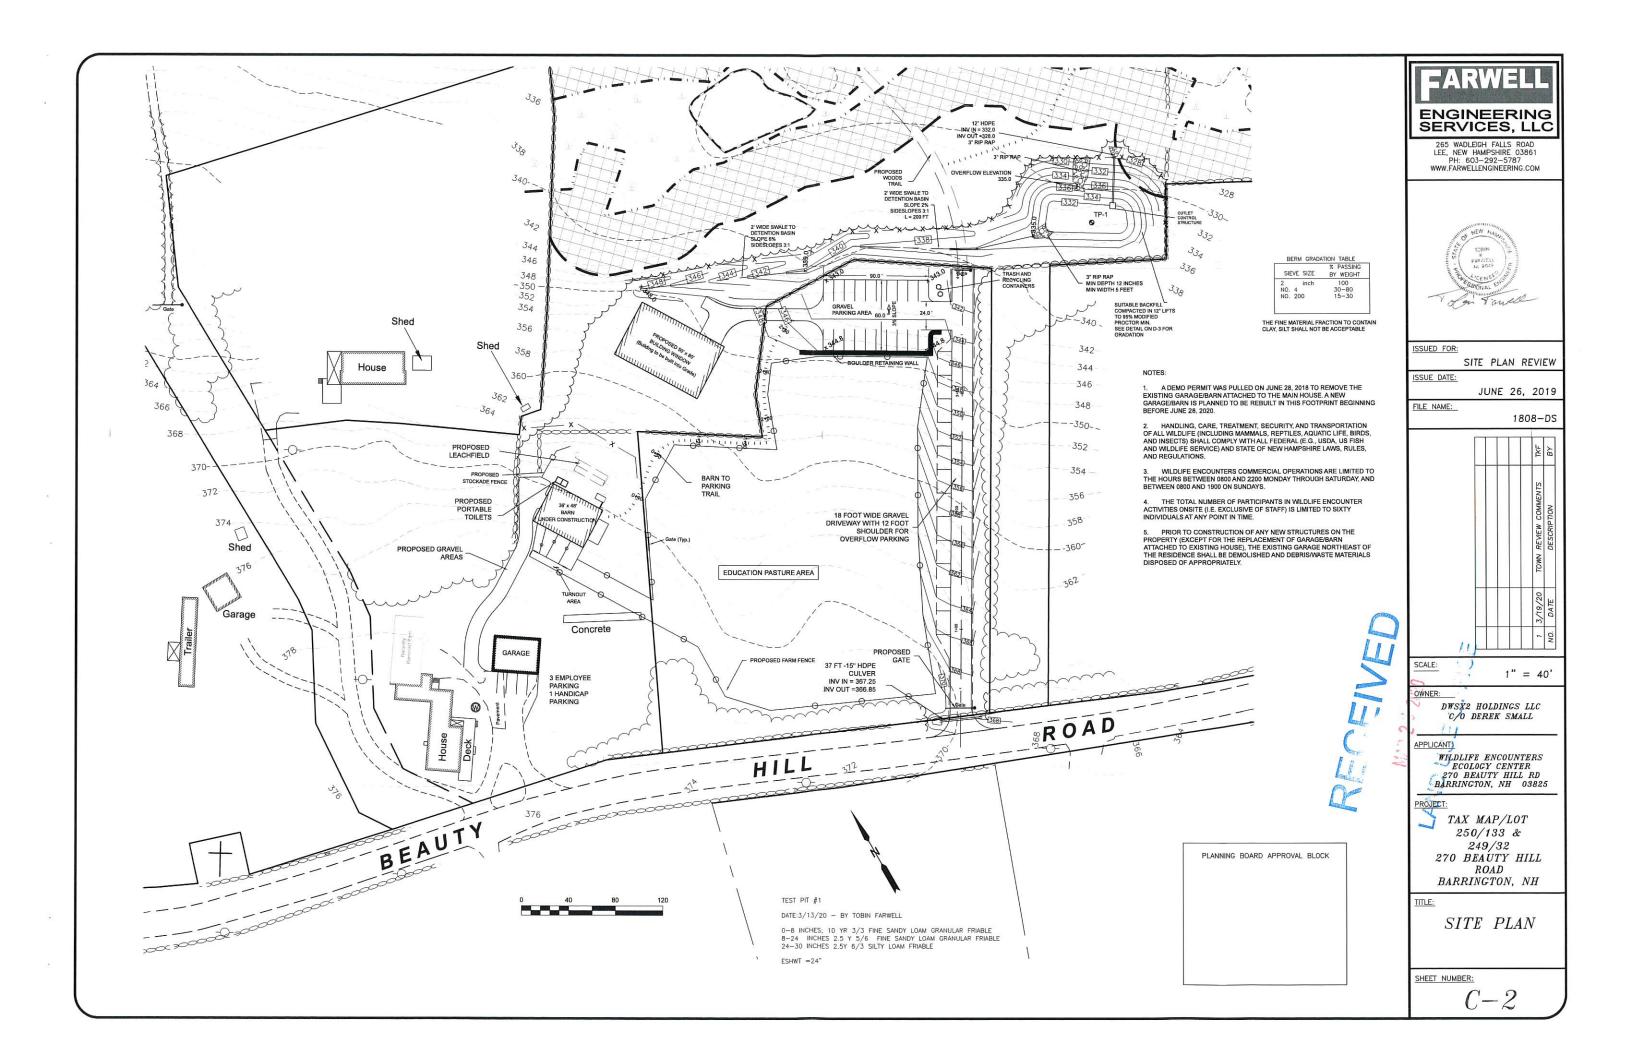

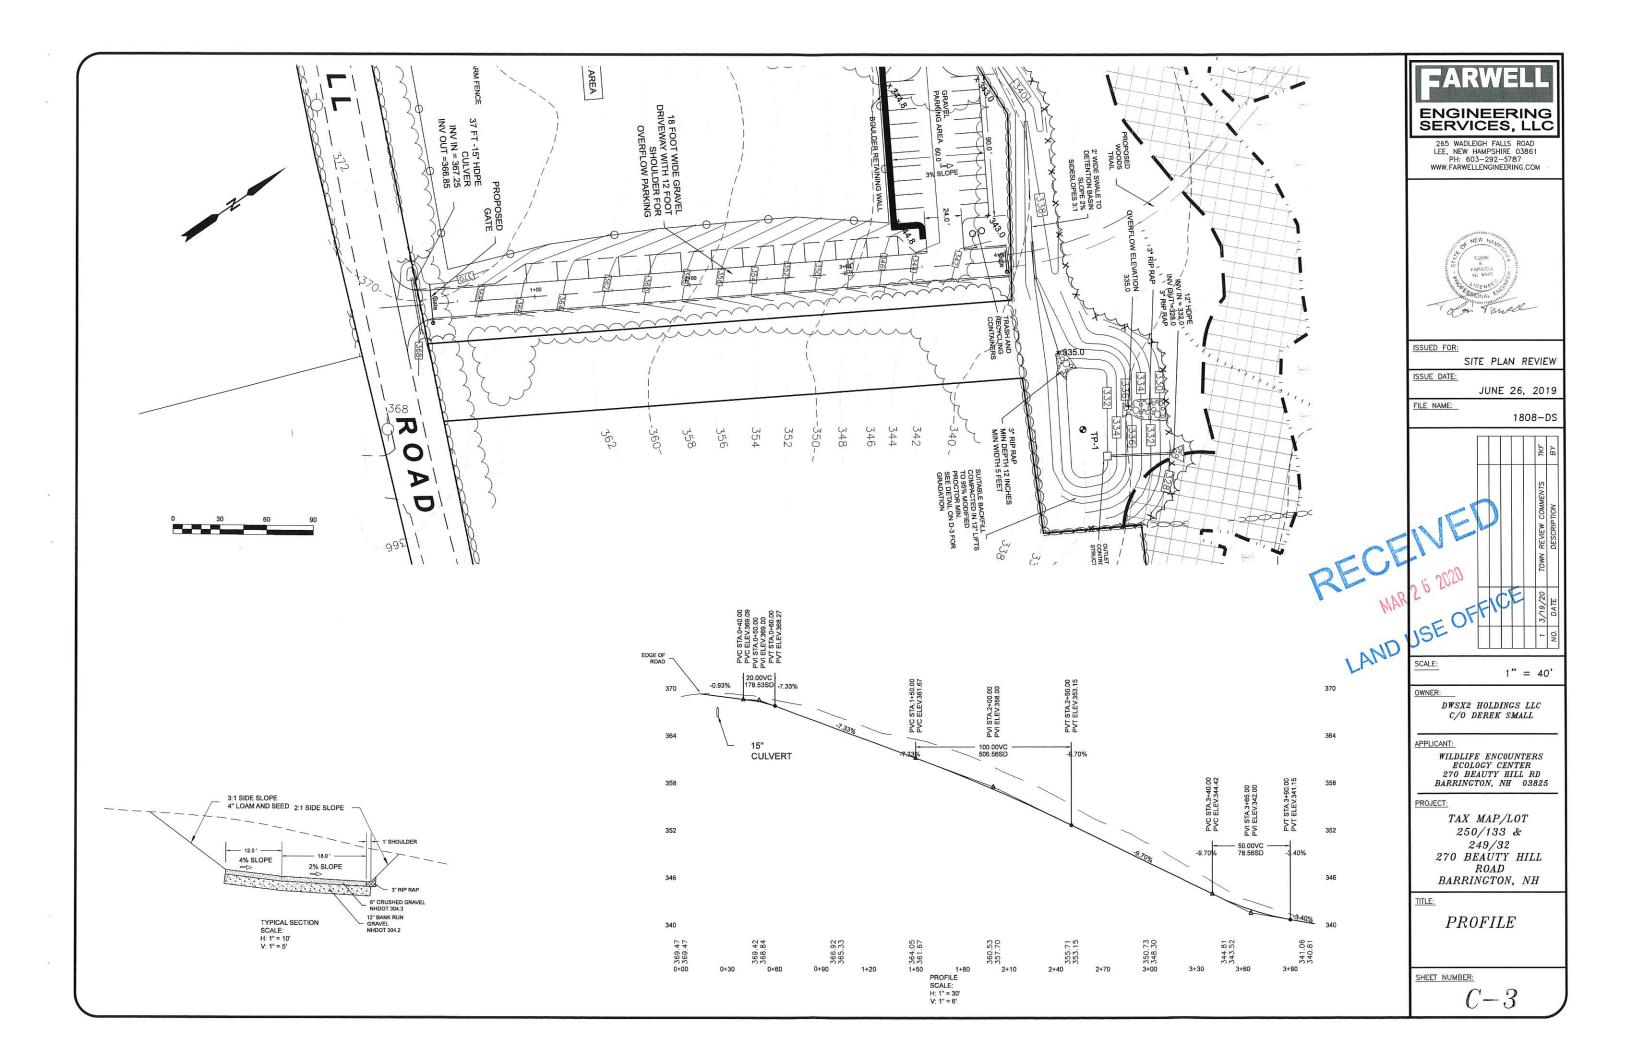

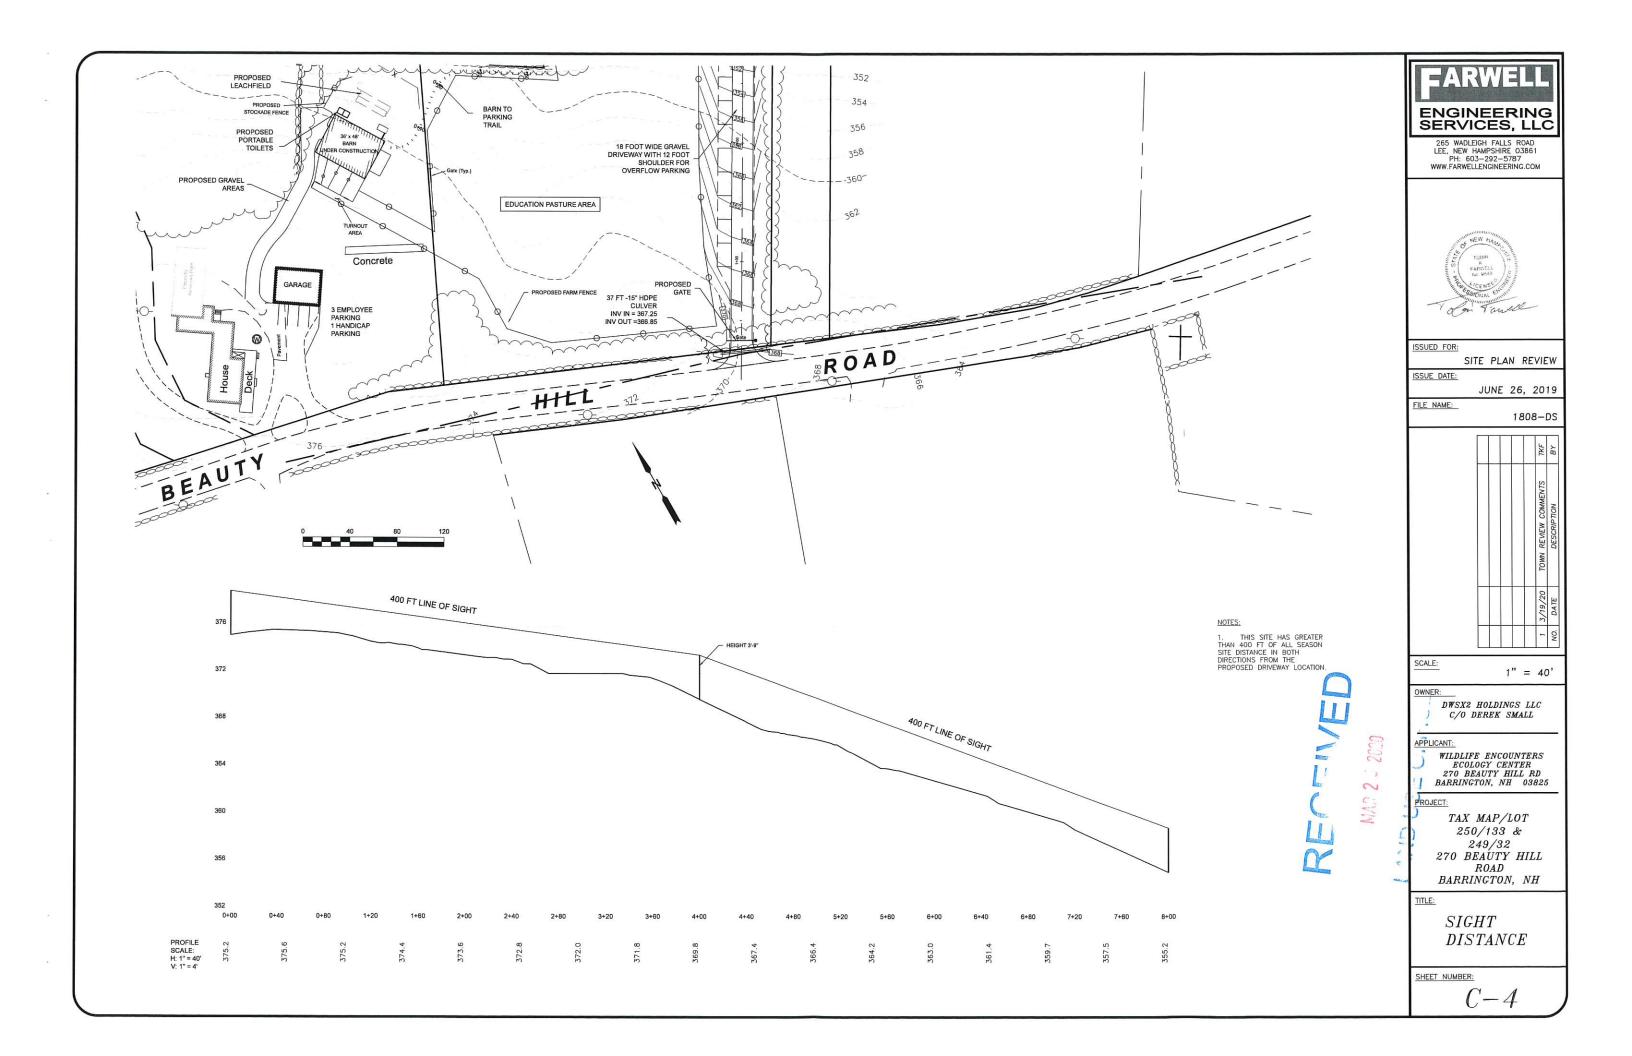

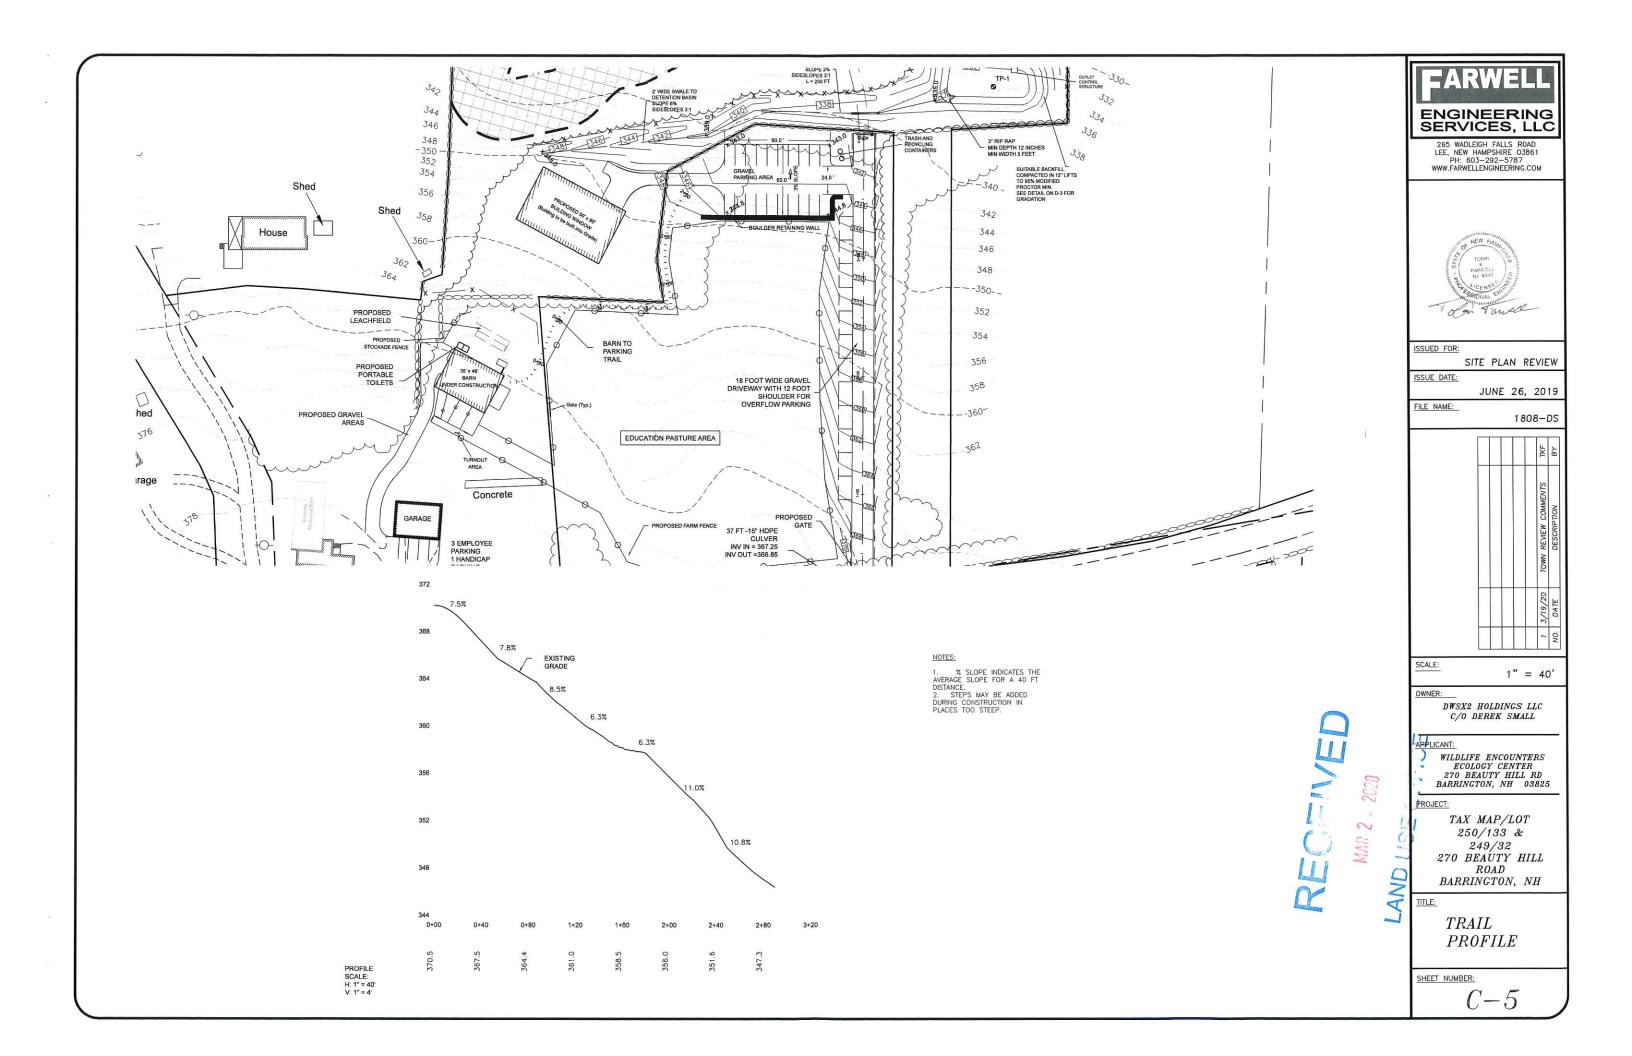

PROJECT NAME AND LOCATION

WILDLIFE ENCOUNTERS 270 BEAUTY HILL ROAD BARRINGTON, NH

LATITUDE: 043' 11' 48" N LONGITUDE: 071' 1' 18" W

DESCRIPTION

PARKING AREA AND ACCESS ROAD. PROPOSED GREENHOUSE AND BARN FOR AGRICULTURAL EDUCATION. DETENTION POND AND SWALE

DISTURBED AREA

THE TOTAL AREA TO BE DISTURBED IS APPROXIMATELY 67,000 sf± (1.5 AC.±)

SEQUENCE OF MAJOR ACTIVITIES

- PERINETER CONTROLS SHALL BE INSTALLED PRIOR TO EARTH MOVING OPERATIONS

 GRUB SITE AND HAUL STUMPS OFF SITE.

 ALL DITCHES AND SWALES SHALL BE STABLIZED PRIOR TO DIRECTING RUNOFF TO THEM.

 ALL ROADWAY SHALL BE STABILIZED WITH 72 HRS OF ACHIEVEING FINISHED GRADE.

 ALL CUT AND FILL SLOPES SHALL BE SECEDE/LOADED WITHIN 72 HRS OF ACHIEVING FINISHED GRADE.

 ALL CUT AND FILL SLOPES SHALL BE SECEDE/LOADED WITHIN 72 HRS OF ACHIEVING FINISHED GRADE.

NAME OF RECEIVING WATERS

BUMFORD BROOK

TEMPORARY EROSION AND SEDIMENT CONTROLS AND STABILIZATION PRACTICES

AS INDICATED IN THE SEQUENCE OF MAJOR ACTIVITIES THE SILT FENCES/SILT SOCK SHALL BE INSTALLED PRIOR TO COMMENCING ANY CLEARING OR GRADING OF THE SITE. STRUCTURAL CONTROLS SHALL BE INSTALLED CONCURRENTLY WITH THE APPLICABLE ACTIVITY. AREAS WHERE CONSTRUCTION ACTIVITY TEMPORARILY CEASES FOR MORE THAN TWENTY EIGHT (28) DAYS WILL BE STABILIZED WITH A TEMPORARY SEED AND MULCH WITHIN TWENTY—ONE (21) DAYS OF THE LAST DISTURBANCE. ONCE CONSTRUCTION ACTIVITY IS COMPLETED IN AN AREA, SILT FENCES/SILT SOCK, BARRIERS AND ANY EARTH/DIKES WILL BE REMOVED ONCE PERMANENT MEASURES ARE ESTABLISHED.

DURING CONSTRUCTION, RUNOFF WILL BE DIVERTED AROUND THE SITE WITH STABILIZED CHANNELS WHERE POSSIBLE. SHEET RUNOFF FROM THE SITE WILL BE FILTERED THROUGH SILT FENCES/SILT SOCK.

INSTALLATION, MAINTENANCE AND INSPECTION PROCEDURES FOR TEMPORARY EROSION AND SEDIMENT CONTROL MEASURES

THESE ARE THE GENERAL INSPECTION AND MAINTENANCE PRACTICES THAT WILL BE USED TO IMPLEMENT THE PLAN.

- 1. THE SMALLEST PRACTICAL PORTION OF THE SITE WILL BE DENUDED AT ONE TIME.
- ALL CONTROL MEASURES WILL BE INSPECTED AT LEAST ONCE EACH WEEK AND FOLLOWING ANY STORM EVENT OF 0.5 INCHES OR GREATER.
- ALL MEASURES WILL BE MAINTAINED IN GOOD WORKING ORDER; IF A REPAIR IS NECESSARY, IT WILL BE INITIATED WITHIN 24 HOURS.
- BUILT UP SEDIMENT WILL BE REMOVED FROM SILT FENCE OR HAY BALE BARRIERS WHEN IT
 HAS REACHED ONE THIRD THE HEIGHT OF THE FENCE OR BALE, OR WHEN "BULGES" OCCUR.
- 5. ALL DIVERSION DIKES WILL BE INSPECTED AND ANY BREACHES PROMPTLY REPAIRED.
- TEMPORARY SEEDING AND PLANTING WILL BE INSPECTED FOR BARE SPOTS, WASHOUTS, AND UNHEALTHY GROWTH.
- 7. A MAINTENANCE INSPECTION REPORT WILL BE MADE AFTER EACH INSPECTION.
- THE CONTRACTOR'S SITE SUPERINTENDENT WILL BE RESPONSIBLE FOR INSPECTIONS, MAINTENANCE AND REPAIR ACTIVITIES, AND FILLING OUT THE INSPECTION AND MAINTENANCE REPORT.
- THE OWNER'S AUTHORIZED ENGINEER SHALL INSPECT THE SITE ON A PERIODIC BASIS TO ASSURE COMPLIANCE WITH THE PLANS.

B. MUI CHING

- MULCHING MULCH SHOULD BE USED ON HIGHLY ERODIBLE SOILS, ON CRITICALLY ERODING AREAS, ON AREAS WHERE CONSERVATION OF MOISTURE WILL FACILITATE PLANT ESTABLISHMENT, AND WHERE SHOWN ON THE PLANS. IN ORDER FOR MULCH TO BE EFFECTIVE, IT MUST BE IN PLACE PRIOR TO MAJOR STORM EVENTS. THERE ARE TWO (2) TYPES OF STANDARDS WHICH SHALL BE USED TO ASSURE THIS
- A. APPLY MULCH PRIOR TO ANY STORM EVENT. THIS IS APPLICABLE WHEN WORKING WITHIN 100 FEET OF WETLANDS. IT WILL BE NECESSARY TO CLOSELY MONITOR WEATHER PREDICTIONS, USUALLY BY CONTACTING THE NATIONAL WEATHER SERVICE IN CONCORD, TO HAVE ADEQUATE WARNING OF SIGNIFICANT STORMS.
- REQUIRED MULCHING WITHIN A SPECIFIED TIME PERIOD. THE TIME PERIOD CAN RANGE FROM 21 TO 28 DAYS OF INACTIVITY ON A AREA, THE LENGTH OF TIME VARYING ACCORDING TO SITE CONDITIONS. PROFESSIONAL JUDGWENT SHALL BE USED TO EVALUATE THE INTERACTION OF SITE CONDITIONS (SOIL ERODIBILITY, SEASON OF YEAR, EXTENT OF DISTURBANCE, PROXIMITY TO SENSITIVE RESOURCES, ETC.) AND THE POTENTIAL IMPACT OF EROSION ON ADJACENT AREAS TO CHOOSE AN APPROPRIATE TIME RESTRICTION.
- A. ALL PROPOSED POST—DEVELOPMENT VEGETATED AREAS WHICH DO NOT EXHIBIT A MINIMUM OF 85% VEGETATIVE GROWTH BY OCTOBER 15TH OR WHICH ARE DISTURBED AFTER OCTOBER 15TH SHALL BE STABILIZED BY SEEDING AND INSTALLING EROSION CONTROL BLANKETS ON SLOPES GREATER THAN 3-1, AND SEEDING AND PLACING 3 TO 4 TONS OF MULCH PER ACRE, SECURED WITH ANCHOR NETTING, ELSEWHERE. THE PLACEMENT OF EROSION CONTROL BLANKETS OR MULCH AND NETTING SHALL NOT OCCUR OVER ACCUMULATED SNOW OR ON FROZEN GROUND AND SHALL BE COMPLETED IN ADVANCE OF THAW OR SPRING MELT EVENTS.

B. ALL DITCHES OR SWALES WHICH DO NOT EXHIBIT A MINIMUM OF 85% VEGETATIVE GROWTH BY OCTOBER 15TH OR WHICH ARE DISTURBED AFTER OCTOBER 15TH SHALL BE STABILIZED WITH STONE OR EROSION CONTROL BLANKETS APPROPRIATE FOR THE DESIGN FLOW CONDITIONS.

C. AFTER NOVEMBER 15TH, INCOMPLETE ROAD OR PARKING SURFACES SHALL BE PROTECTED WITH A MINIMUM OF 3-INCHES OF CRUSHED GRAVEL PER NHDOT ITEM 304.3 OR IF CONSTRUCTION IS TO CONTINUE THROUGH THE WINTER SEASON BE CLEARED OF ANY ACCUMULATED SNOW AFTER EACH STORM EVENT.

MAINTENANCE
ALL MULCHES MUST BE INSPECTED PERIODICALLY, IN PARTICULAR AFTER
RAINSTORMS, TO CHECK FOR RILL EROSION. IF LESS THAN 90% OF THE
SOIL SURFACE IS COVERED BY MULCH, ADDITIONAL MULCH SHALL BE
IMMEDIATELY APPLIED.

C. TEMPORARY GRASS COVER

- SEEDBED PREPARATION APPLY FERTILIZER AT THE RATE OF 600 POUNDS PER ACRE OF 10-10-10. APPLY LIMESTONE (EQUIVALENT TO 50 PERCENT CALCIUM PLUS MAGNESIUM OXIDE) AT A RATE OF THREE (3) TONS PER ACRE.

- UTILIZE ANNUAL RYE GRASS AT A RATE OF 40 LBS/ACRE.
 WHERE THE SOIL HAS BEEN COMPACTED BY CONSTRUCTION OPERATIONS, LOOSEN
 SOIL TO A DEPTH OF TWO (2) INCHES BEFORE APPLYING FERTILIZER, LIME AND
 SEED.
- APPLY SEED UNIFORMLY BY HAND, CYCLONE SEEDER, OR HYDROSEEDER (SLURRY INCLUDING SEED AND FERTILIZER). HYDROSEEDINGS, WHICH INCLUDE MULCH, MAY BE LEFT ON SOIL SURFACE.

 SEEDING RATES MUST BE INCREASED 10% WHEN HYDROSEEDING.

MAINTENANCE
TEMPORARY SEEDINGS SHALL BE PERIODICALLY INSPECTED. AT A MINIMUM, 95% OF
THE SOIL SURFACE SHOULD BE COVERED BY VEGETATION. IF ANY EVIDENCE
OF EROSION OR SEDIMENTATION IS APPARENT, REPAIRS SHALL BE MADE AND
OTHER TEMPORARY MEASURES USED IN THE INTERIM (MULCH, FILTER
BARRIERS, CHECK DAMS, ETC.).

D. FILTERS

SILT FENCE
 A. SYNTHETIC FILTER FABRIC SHALL BE A PERVIOUS SHEET OF PROPYLENE, NYLON, POLYESTER OR ETHYLENE YARN AND SHALL BE CERTIFIED BY THE MANUFACTURER OR SUPPLIER AS CONFORMING TO THE FOLLOWING REQUIREMENTS:

	SILT FENCE PROPERTIES	
PHYSICAL PROPERTY	TEST	REQUIREMENTS
GRABE TENSILE	ASTM-D-4632	95/80 LB
PUNCTURE	ASTM-D-4833	45 LB
FLOW RATE	ASTM-D-4491	5 GAL/MIN/SF
UV RESISTANCE	ASTM D-4751	80%
GRAB ELONGATION	ASTM D-4632	20/25%

Requirements reduced by 50 percent after six (6) months of

SYNTHETIC FILTER FABRIC SHALL CONTAIN ULTRAVIOLET RAY INHIBITORS AND STABILIZERS TO PROVIDE A MINIMUM OF SIX (6) MONTHS OF EXPECTED USABLE CONSTRUCTION LIFE AT A TEMPERATURE RANGE OF O DEGREES F TO 120° F.

- POSTS SHALL BE SPACED A MAXIMUM OF TEN (10) FEET APART AT THE BARRIER LOCATION OR AS RECOMMENDED BY THE MANUFACTURER AND DRIVEN SECURELY INTO THE GROUND (MINIMUM OF 16 INCHES).
- A TRENCH SHALL BE EXCAVATED APPROXIMATELY SIX (6) INCHES WIDE AND SIX (6) INCHES DEEP ALONG THE LINE OF POSTS AND UPSLOPE FROM THE BARRIER.
- WHEN STANDARD STRENGTH FILTER FABRIC IS USED, A WIRE MESH SUPPORT FENCE SHALL BE FASTENED SECURELY TO THE UPSLOPE SIDE OF THE POSTS USING HEAVY DUTY WIRE STAFLES AT LEAST ONE (1) INCH LONG, TIE WIRES OR HOG RINGS. THE WIRE SHALL EXTEND NO MORE THAN 36 INCHES ABOVE THE ORIGINAL GROUND SUPFRACES.
- E. THE "STANDARD STRENGTH" FILTER FABRIC SHALL BE STAPLED OR WIRED TO THE FENCE, AND SIX (6) INCHES OF THE FABRIC SHALL BE EXTENDED INTO THE TRENCH. THE FABRIC SHALL NOT EXTEND MORE THAN 36 INCHES ABOVE THE ORIGINAL GROUND SURFACE. FILTER FABRIC SHALL NOT BE STAPLED TO EXISTING TREES.
- WHEN EXTRA STRENGTH FILTER FABRIC AND CLOSER POST SPACING ARE USED. THE WIRE MESH SUPPORT FIRENE MAY BE ELIMINATED. IN SUCH A CASE, THE FILTER FABRIC IS STAPLED OR WIRED DIRECTLY TO THE POSTS WITH ALL OTHER
- SILT FENCES SHALL BE REMOVED WHEN THEY HAVE SERVED THEIR USEFUL PURPOSE BUT NOT BEFORE THE UPSLOPE AREAS HAVE BEEN PERMANENTLY STABILIZED.

SEDIMENT BARRIERS SHALL BE INSTALLED PRIOR TO ANY SOIL DISTURBANCE OF THE CONTRIBUTINGDRAINAGE UPSLOPE OF THEM.

3. MAINTENANCE


- SILT FENCE BARRIERS SHALL BE INSPECTED IMMEDIATELY AFTER EACH RAINFALL AND AT LEAST DAILY DURING PROLONGED RAINFALL. THEY SHALL BE REPAIRED IF THERE ARE ANY SIGNS OF EROSION OR SEDIMENTATION BELOW THEM. ANY REQUIRED REPAIR SHALL BE MADE IMMEDIATELY. IF THERE ARE SIGNS OF UNDERCUTTING AT THE CENTER OR THE EGGES. OR IMPOUNDING OF LARGE VOLUMES OF WATER, THE SEDIMENT BARRIERS SHALL BE REPLACED WITH A TEMPORARY CHECK DAM.
- SHOULD THE FABRIC ON A SILT FENCE FILTER BARRIER DECOMPOSE OR BECOME INEFFECTIVE PRIOR TO THE END OF THE EXPECTED USABLE LIFE AND THE BARRIER IS STILL NECESSARY, THE FABRIC SHALL BE REPLACED PROMPILY.
- C. SEDIMENT DEPOSITS MUST BE REMOVED WHEN DEPOSITS REACH APPROXIMATELY ONE THIRD (1/3) THE HEIGHT OF THE BARRIER.
- ADDITIONAL STONE MAY HAVE TO BE ADDED TO THE CONSTRUCTION ENTRANCE, ROCK BARRIER STONE LINED SWALES, ETC., PERIODICALLY TO MAINTAIN PROPER FUNCTION OF THE EROSION CONTROL STRUCTURE.

E. PERMANENT SEEDING


- BEDDING STONES LARGER THAN 1", TRASH, ROOTS, AND OTHER DEBRIS THAT WILL INTERFERE WITH SEEDING AND FUTURE MAINTENANCE OF THE AREA SHOULD BE REMOVED. WHERE FEASIBLE, THE SOIL SHOULD BE TILLED TO A DEPTH OF 4" TO PREPARE A SEEDBED AND MIX FERTILIZER INTO THE SOIL.
- FERTILIZER LIME AND FERTILIZER SHOULD BE APPLIED EVENLY OVER THE AREA PRIOR TO OR AT THE TIME OF SEEDING AND INCORPORATED INTO THE SOIL. KINDS AND AMOUNTS OF LIME AND FERTILIZER SHOULD BE BASED ON AN EVALUATION OF SOIL TESTS. WHEN A SOIL TEST IS NOT AVAILABLE, THE FOLLOWING MINIMUM AMOUNTS SHOULD BE APPLIED: AGRICULTURAL LIMESTONE © 100 LBS. PER 1,000 S.F. 10-20-20 FERTILIZER © 12 LBS. PER 1,000 S.F. SEED MIXTURE (RECOMMENDED):
- GRASS SEED: PROVIDE FRESH, CLEAN, NEW-CROP
 SEED COMPLYING WITH TOLERANCE FOR PURITY AND GERMINATION ESTABLISHED BY OFFICIAL SEED
 ANALYSTS OF NORTH AMERICA. PROVIDE SEED MIXTURE COMPOSED OF GRASS SPECIES, PROPORTIONS
 AND MINIMUM PERCENTAGES OF PURITY AS SPECIFIED.

Name	Proportion by Weight	% Germination	
Baron Bluegrass	20%	80	
Kentucky Bluegrass	20%	80	
Creeping Red Fescue	35%	85	
Champion Perennial Ryegrass	25%	90	


SODDING — SODDING IS DONE WHERE IT IS DESIRABLE TO RAPIDLY ESTABLISH COVER ON A DISTURBED AREA. SODDING AN AREA MAY BE SUBSTITUTED FOR PERMANENT SEEDING PROCEDURES ANYWHERE ON SITE. BED PREPARATION, FETTILIZING, AND PLACEMENT OF SOD SHALL BE PERFORMED ACCORDING TO THE S.C.S. HANDBOOK. SODDING IS RECOMMENDED FOR STEEP SLOPED AREAS, AREAS IMMEDIATELY ADJACENT TO A SENSITIVE WATER COURSE, EASILY

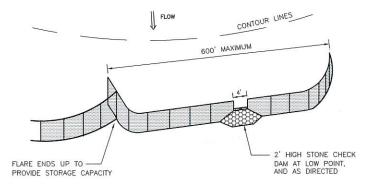

SILT FENCE LAYOUT TO SCALE

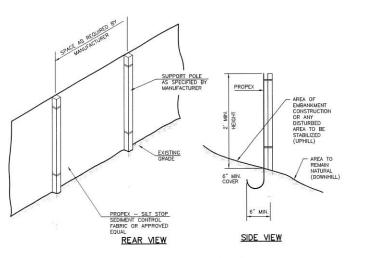

SILT FENCE DETAIL

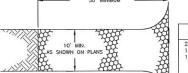

PLAN VIEW

PROFILE

2. LENGTH - DETAILED ON PLANS (50 FOOT MINIMUM) 3. THICKNESS - SIX (6) INCHES (MINIMUM).

4. WIDTH - FULL DRIVE WIDTH (10 FOOT MINIMUM)

5. FILTER FABRIC - MIRAFI 600X OR APPROVED EQUAL.

CONSTRUCTION SPECIFICATIONS

EXISTING

			% PASSIN	
SIEVE SIZE		SIZE	BY WEIGH	
2	i aso	inch	100	
1	1/2	inch	90-100	
1	0.53330	inch	20-55	
3/4 in		inch	0-15	
	3/8	inch	0-5	

PAVEMENT

EXISTING

ENGINEERING SERVICES, LLC

265 WADLEIGH FALLS ROAD LEE, NEW HAMPSHIRE 03861 PH: 603-292-5787 WWW.FARWELLENGINEERING.COM



ISSUED FOR

ISSUE DATE:

SITE PLAN REVIEW

JUNE 26, 2019

FILE NAME:

1808-DS


STABILIZED CONSTRUCTION ENTRANCE


WHEELS SHALL BE CLEANED TO REMOVE MUD PRIOR TO ENTRANCE ONTO PUBLIC RIGHTS—OF—WAY, WHEN WASHING IS REQUIRED, IT SHALL BE DONE ON AN AREA STABILIZED WITH STONE WHICH DRAINS INTO AN APPROVED SEDIMENT TRAPPING DEVICE.

STONE SIZE — NHDOT STANDARD STONE SIZE #4 — SECTION 703 OF NHDOT STANDARD SPECIFICATIONS. (SEE GRADATION TABLE)

SURFACE WATER CONTROL — ALL SURFACE WATER THAT IS FLOWING TO OR DIVERTED TOWARD THE CONSTRUCTION ENTRANCE SHALL BE PIPED BENEATH THE ENTRANCE IF PIPING IS IMPRACTICAL, A BERN WITH 5:1 SLOPES THAT CAN BE CROSSED BY VEHICLES MAY BE SUBSTITUTED FOR THE PIPE.

MAINTENANCE — THE ENTRANCE SHALL BE MAINTAINED IN A CONDITION WHICH WILL PREVENT TRACKING OR FLOWING OF SEDIMENT ONTO PUBLIC RIGHTS-WAY. THIS WILL REQUIRE PERIODIC TOP DRESSING WITH ADDITIONAL STONE OR ADDITIONAL LIVERTH AS CONDITIONS DEMAND AND REPAIR AND/OR CLENWOUT F ANY MESURES USED TO TRAP SEDMENT. ALL SEDIMENT SPILLED, PROPPED, WASHED OR TRACKED ONTO PUBLIC RIGHTS-OF-WAY MUST BE REMOVED IMMEDIATELY.

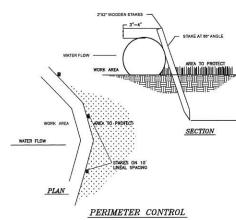

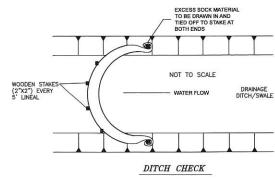

NOTE: FOLLOW MANUFACTURER'S SPECIFICATION Modified from Filtrexx Standard Specification and Design Manual, Version 5.0, 2006

SILT SOCK DETAIL



SCALE:

DWSX2 HOLDINGS LLC C/O DEREK SMALL

APPLICANT:

OWNER:

WILDLIFE ENCOUNTERS ECOLOGY CENTER 270 BEAUTY HILL RD BARRINGTON, NH 03825

1" = 40'


PROJECT

TAX MAP/LOT 250/133 & 249/32 270 BEAUTY HILL ROAD BARRINGTON, NH

TITLE:

DETAILS


SHEET NUMBER:

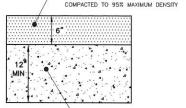


6" CRUSHED GRAVEL - NHDOT ITEM 304.3

NOTE: ALL LOAM AND YIELDING MATERIAL SHALL BE REMOVED TO A DEPTH OF NO LESS THAN 24" BELOW FINISHED GRADE. INSTALL COMPACTED GRANULAR MATERIAL TO SUBGRADE AS NEEDED.

GRAVEL DRIVE DETAIL NOT TO SCALE

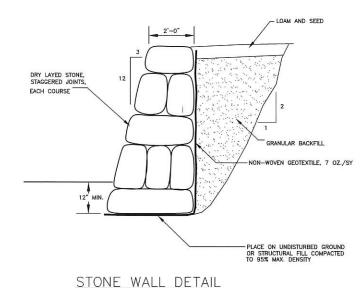

NOT TO SCALE

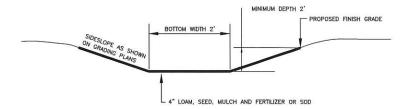


NOTES:

- 1. THE FOUNDATION AREA OF THE WATERWAY SHALL BE CLEARED AND GRUBBED OF ALL TREES, BRUSH, STUMPS, AND OTHER OBJECTIONABLE MATERIAL MATERIALS REMOVED SHALL BE DISPOSED OF SO THEY WILL NOT INTERFERE WITH THE CONSTRUCTION OR PROPER FUNCTIONING OF THE WATERWAY.
- THE WATERWAY SHALL BE EXCAVATED OR SHAPED TO LINE, GRADE AND CROSS SECTION AS REQUIRED TO MEET THE DESIGN CRITERIA. THE WATERWAY SHALL BE FREE OF IRREGULARITIES WHICH WILL IMPEDE NORMAL FLOW.
- CONSTRUCTION OPERATIONS SHALL BE CARRIED OUT IN SUCH A MANNER AS TO MINIMIZE EROSION AND AIR AND WATER POLLUTION. ALL APPROPRIATI STATE AND LOCAL LAWS AND REGULATIONS SHALL BE COMPUED WITH FOR INSTALLATION.
- 5. VEGETATION SHALL BE ESTABLISHED IN THE SWALE PRIOR TO ALLOWING STORMWATER RUNOFF TO FLOW THROUGH THE SWALE.
- THE WATERWAY SHOULD BE INSPECTED PERIODICALLY AND AFTER EVERY MAJOR STORM TO DETERMINE THE CONDITION OF THE WATERWAY. RILLS AND DAMAGED AREAS SHOULD BE PROMPTLY REPAIRED AND REVEGETATED AS NECESSARY TO PREVENT FURTHER DETERIORATION.
- 8. PERIODIC APPLICATIONS OF LIME AND FERTILIZER MAY BE NEEDED TO MAINTAIN VIGOROUS GROWTH.

GRASSED SWALE

NOT TO SCALE

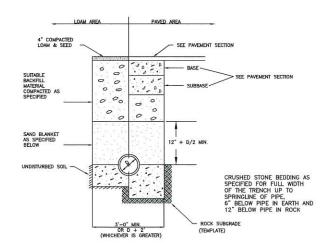


BACKFILL MATERIAL BELOW PAVED OR CONCRETE AREAS, BEDDING MATERIAL, AND SAND BLANKET SHALL BE COMPACTED TO NOT LESS THAN 95% OF AASHTO T 99. METHOD C. SUITABLE BACKFILL MATERIAL BELOW LOAM AREAS SHALL BE COMPACTED TO NOT LESS THAN 90% OF AASHTO T 99, METHOD C.

SAND BLANKET & BEDDING		CRUSHED STONE BEDDING *		
SIEVE SIZE	% FINER BY WEIGHT	SIEVE SIZE	% FINER BY WEIGHT	
1/2"	90 - 100	1*	100	
200	0 - 15	3/4"	90 - 100	
		3/8"	20 - 55	
		# 4	0 - 10	
		# 8	0 5	

EQUIVALENT TO STANDARD STONE SIZE #67 — SECTION 703 OF NHDOT STANDARD SPECIFICATIONS

TRENCH DETAIL

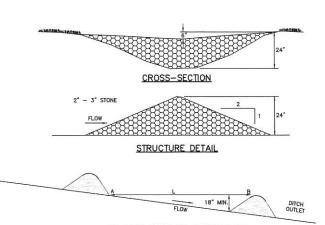

SPACING BETWEEN STRUCTURES

- CHECK DAM SHALL BE CONSTRUCTED OF 2" TO 3" STONE WITH COMPLETE COVERAGE OF DITCH OR SWALE TO INSURE THAT THE CENTER OF THE STRUCTURE IS LOWER THAN THE EDGES.

MAINTENANCE


TEMPORARY GRADE STABILIZATION STRUCTURES SHOULD BE CHECKED AFTER EACH RAINFALL AND AT LEAST DALLY DURING PROLONGED STORMS. ANY NECESSARY REPARS SHOULD BE MADE AMBEDIATELY, PARTICULAR STRUCTURE. BE GREN TO END RUN AND EROSION AT THE DOWNSTREAM TOE OF THE STRUCTURE. WHEN THE STRUCTURES ARE REMOVED, THE DISTURBED PORTION SHOULD BE BROUGHT TO THE EXISTING CHANNEL GRADE AND THE AREAS PREPARED, SECUED, AND MULCHED. WHILE THIS PRACTICE IS NOT INTENDED TO BE USED PRIMARILY FOR SEDMENT TRAPPING, SOME SEDMENT WILL ACCUMULATE BEHIND THE STRUCTURES, SEDMENT SHALL BE REMOVED FROM BEHIND THE STRUCTURES WHEN IT HAS ACCUMULATED TO ONE HALF OF THE ORIGINAL HEIGHT OF THE STRUCTURES.

CONSTRUCTION SPECIFICATIONS

- STRUCTURES SHALL BE INSTALLED ACCORDING TO THE DIMENSIONS SHOWN ON THE PLANS AT THE APPROPRIATE SPACING.
 CONSTRUCTION OPERATIONS SHALL BE CARRIED OUT IN SUCH A MANNER SO THAT EMOSION AND ARE AND WATER POLLUTION WILL BE MINIMIZED.
 IN THE APPROPRIATE SECRETATIVE BUY. ALL CONFORM TO THE RECOMMENDATIONS IN THE APPROPRIATE CECETATIVE BUY.
 STRUCTURES SHALL BE REMOVED FROM THE CHANNEL WHEN THEIR USEFUL LIFE HAS BEEN COMPLETED.

STONE CHECK DAM DETAIL

NOT TO SCALE

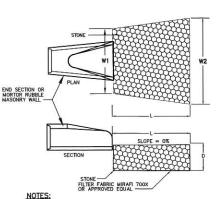

1. STONE SIZE AND MAT DIMENSIONS DETAILED ON SITE PLANS.

- 2. FIELD STONE, QUARRY STONE, OR ROCK FRAGMENTS SHALL BE SOUND, OF APPROVED QUALITY, AND FREE FROM STRUCTURAL DEFECTS. THE STONES SHALL BE ANGULAR AND APPROXIMATELY RECTANGULAR IN SHAPE. FLAT OR ROUND ROCKS ARE NOT ACCEPTABLE.
- 3. A WELL GRADED MIXTURE OF ROCK SIZES SHALL BE USED FOR STONE. FIFTY PERCENT BY WEIGHT OF THE STONE MIXTURE SHALL BE SMALLER THAN THE MEDIAN SIZE STONE (d50). THE LARGEST STONE SIZE IN THE MIXTURE SHALL BE 1.5 TIMES THE d50 SIZE.

RIP RAP OUTLET PROTECTION

NOT TO SCALE



265 WADLEIGH FALLS ROAD LEE, NEW HAMPSHIRE 03861 PH: 603–292–5787 WWW.FARWELLENGINEERING.COM



ISSUED FOR:

SITE PLAN REVIEW

ISSUE DATE:

JUNE 26, 2019

FILE NAME: 1808-DS CWI

SCALE:

OWNER:

DWSX2 HOLDINGS LLC C/O DEREK SMALL

1" = 40'

APPLICANT:

WILDLIFE ENCOUNTERS ECOLOGY CENTER 270 BEAUTY HILL RD BARRINGTON, NH 03825


PROJECT:

TAX MAP/LOT 250/133 & 249/32 270 BEAUTY HILL ROADBARRINGTON, NH

TITLE:


DETAILS

SHEET NUMBER:

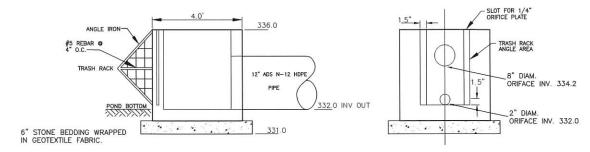

SIDE VIEW

FRONT VIEW

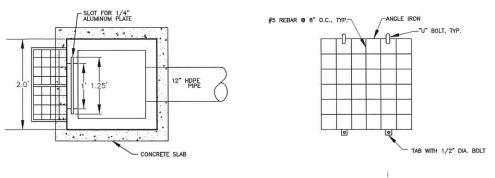


TOP VIEW

POND STRUCTURE COVER

OUTLET STRUCTURE #1

NOT TO SCALE

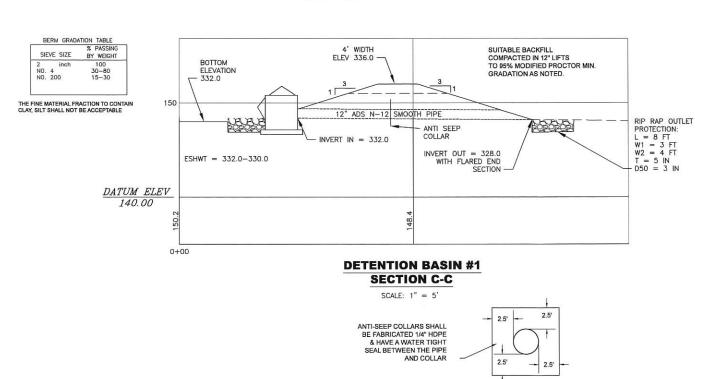

ANTI-SEEP COLLAR DETAIL

SCALE: NOT TO SCALE



265 WADLEIGH FALLS ROAD LEE, NEW HAMPSHIRE 03861 PH: 603-292-5787 WWW.FARWELLENGINEERING.COM



ISSUED FOR:

SITE PLAN REVIEW

ISSUE DATE:

JUNE 26, 2019

FILE NAME: 1808-DS

AND USE OFFICE

1 3/19/20 TOWN REVEW COMMENTS TKF

NO. DATE

NO. DATE

SCALE:

1" = 40'

OWNER:

DWSX2 HOLDINGS LLC C/O DEREK SMALL

APPLICANT:

WILDLIFE ENCOUNTERS
ECOLOGY CENTER
270 BEAUTY HILL RD
BARRINGTON, NH 03825

PROJECT:

TAX MAP/LOT
250/133 &
249/32
270 BEAUTY HILL
ROAD
BARRINGTON, NH

TITLE:

DETAILS

SHEET NUMBER:

D-3

